

THESE PLANS HAVE BEEN PREPARED TO THE BEST OF OUR ABILITY WITH THE INFORMATION AVAILABLE TO US. DUE TO THE NATURE OF A RENOVATION/ADDITION TO AN EXISTING STRUCTURE THE ARCHITECT MUST BE NOTIFIED FOR ANY REVISIONS, STRUCTURAL MODIFICATIONS OR SUPPORT REQUIREMENTS RESULTING FROM UNFORSEEN CONDITIONS SUCH AS EXISTING COLUMNS, DUCTS, PIPING, ETC. ENCLOSED IN EXISTING WALLS, CEILINGS, ETC.... G.C. TO CONTACT R.A. UPON ANY UNFORSEEN CONDITIONS ARISING.

PROPERTY OWNER(S)

NAME: SUFFOLK SK, LLC.

CONTACT: eMAIL: KEVINBASSO@GMAIL.COM

TEL: (631) 949-6550 OR SHIRLEY BASSO (646) 423-8950

TENANT NAME: BEAVER DAM BREWING COMPANY
SQ. FT. OF TENANT SPACE: (6,426 SQ. FT.)

OCCUPANCY: GROUP B
USE: INDUSTRIAL

ALLOWABLE HEIGHT:	55'-0"
ACTUAL HEIGHT:	18'-0"

NO. OF STORIES:	2
TOTAL FLOOR AREA:	6,426 SQ. FT.

CONSTRUCTION TYPE: TYPE II B (601,602)

FIRE RESISTANCE RATING REQUIREMENTS FOR BUILDING ELEMENTS:
(BASED UPON TYPE II B)

STRUCTURAL FRAME (INCLUDING COLUMNS, GIRDERS, TRUSSES):	0 HR(S)
BEARING WALLS (EXTERIOR):	1 HR(S)
NONBEARING WALLS (INTERIOR & EXTERIOR):	0 HR(S)
FLOOR CONSTRUCTION (INCLUDING SUPPORT BEAMS & JOISTS):	0 HR(S)
ROOF CONSTRUCTION (INCLUDING SUPPORT BEAMS & JOISTS):	0 HR(S)

OCCUPANCY:	B
INTERIOR FINISH REQUIREMENTS:	B
VERTICAL EXITS & EXIT PASSAGEWAYS:	B
EXIT ACCESS CORRIDORS & OTHER EXITWAYS:	C
ROOMS & ENCLOSED SPACES:	C

(CLASS DESIGNATION WITH SURFACE FLAME SPREAD RATING: A:0-25 B:26-75 C:76-200)

FIRE PROTECTION SYSTEM REQUIREMENTS:			
SPRINKLER SYSTEM (903.2)	REQUIRED:	NO	PROVIDED: NO
STANDPIPE SYSTEM (905)	REQUIRED:	NO	PROVIDED: NO
FIRE & SMOKE DETECTION: (907)	REQUIRED:	NO	PROVIDED: NO
FIRE ALARM: (907.2.7)	REQUIRED:	NO	PROVIDED: NO
SMOKE VENTS: (910)	REQUIRED:	NO	PROVIDED: NO
POTABLE FIRE EXTINGUISHER:	REQUIRED:	YES	PROVIDED: YES

<u>STORE:</u>		
INDUSTRIAL: 60 GROSS	OCC.	60
TOTAL OCCUPANT LOAD:		60

EGRESS REQUIREMENTS:		
EGRESS DOOR WIDTH:(1005.1)	REQUIRED: 49 x 0.2" = 9.8"	PROVIDED:
MIN. DOOR WIDTH:	REQUIRED: 32"	(CLEAR)
NUMBER OF EXITS:(1014.1)	REQUIRED: 2	PROVIDED:
TRAVEL DIST. (W/O SPRINKLER):(1016.1)	REQUIRED: 250'-0"	PROVIDED:

C408.2 MECHANICAL SYSTEMS AND SERVICE WATER-HEATING SYSTEM COMMISSIONING AND COMPLETION REQUIREMENTS. PRIOR TO THE FINAL MECHANICAL AND PLUMBING INSPECTIONS, THE REGISTERED DESIGN PROFESSIONAL OR APPROVED AGENCY SHALL PROVIDE EVIDENCE OF MECHANICAL SYSTEMS COMMISSIONING AND COMPLETION IN ACCORDANCE WITH THE PROVISIONS OF THIS SECTION. CONSTRUCTION DOCUMENT NOTES SHALL CLEARLY INDICATE PROVISIONS FOR COMMISSIONING AND COMPLETION REQUIREMENTS IN ACCORDANCE WITH THIS SECTION AND ARE PERMITTED TO REFER TO SPECIFICATIONS FOR FURTHER REQUIREMENTS. COPIES OF ALL DOCUMENTATION SHALL BE SUBMITTED TO THE OWNER OR OWNER'S REGISTERED AGENT AND TO THE AIA AVAILABLE TO THE CODE OFFICIAL UPON REQUEST IN ACCORDANCE WITH SECTIONS C408.2.4 AND C408.2.5.

EXCEPTIONS: 1. MECHANICAL SYSTEMS AND SERVICE WATER HEATER SYSTEMS IN BUILDINGS WHERE THE TOTAL MECHANICAL EQUIPMENT CAPACITY IS LESS THAN 480,000 BTU/H (140.7 KW) COOLING CAPACITY AND 600,000 BTU/H (175.8 KW) COMBINED SERVICE WATER-HEATING AND SPACE-HEATING CAPACITY.

*THIS PROJECT IS AN EXCEPTION

SCOPE OF WORK

THE USE OF THIS SPACE IS FOR BEAVER DAM BREWING COMPANY, USE GROUP B (BUSINESS). PREVIOUS TENANT WAS A PLUMBING SUPPLY COMPANY.


PROJECT INVOLVES AN ALTERATION LEVEL 2 WITH A CHANGE OF OCCUPANCY CLASSIFICATION UNDER CHAPTER 10 OF THE EXISTING BUILDING CODE OF NEW YORK STATE, WITH AN ALTERATION LEVEL 2 UNDER CHAPTER 8 OF THE EXISTING BUILDING CODE, TO AN 'EXISTING 6,426 SQ.FT. TENANT SPACE'.

THE EXISTING SPACE IS DESIGNATED AS USE GROUP B, AND THE OCCUPANCY CLASSIFICATION SHALL REMAIN B.

THE SCOPE OF WORK IS TO REMOVE A NON-BEARING PARTITION WALL.


NYS BSC 2017 UNIFORM CODE SUPPLEMENT	2016 NYSRC (2015 IRC 2ND PRINTING)	2016 NYSPMC (2015 IPMC 4TH PRINTING)	
NYS BSC 2016 SUPPLEMENT TO THE NYSSECC	2016 NYSEBC (2015 IECB 5TH PRINTING)	ASHRAE 90.1 2013 (JULY 2014 PRINTING)	
	2016 NYSECC (2015 IECC 2ND PRINTING)	ASME A17.1 2013	
2016 NYSBC (2015 IBC 3RD PRINTING)	2016 NYSCF (2015 IFC 3RD PRINTING)		NA

TOPIC	BUILDING CODE SECTION	REQUIRED/ ALLOWED	ACTUAL	HOW AND WHERE IS COMPLIANCE INDICATED
ENERGY CONSERVATION 2017 NYSECC AND 2017 NYSECC SUPPLEMENT (AUGUST 2016) CHOOSE EITHER REFERENCE 2015 IECC OR ASHRAE 90.1 2013(JULY 2014 - PRINTING) FOR COMMERCIAL. 2015 IECC FOR OCCUPANCIES UP TO 3 STORIES	1301/ECC – SEE 2017 NYSECC AND 2017 NYSECC SUPPLEMENT CITE THE ENERGY COMPLIANCE PATHS OF EACH REFERENCE CHOSEN FOR COMPLIANCE	R	P	COMCHECK ATTACHMENT
ELECTRICAL	2701.1	R	P	SEE NOTES THROUGHOUT THIS SET.
EMERGENCY & STANDBY POWER	2702.1	R	P	EMERGENCY LIGHTING BATTERY BALLAST. SEE LIGHTING PLANS.
ELEVATOR & PLATFORM LIFTS	2702.02.02	N/A	N/A	
EXIT SIGNS	2702.02.05	R	P	SEE LIGHTING PLANS FOR EXIT SIGNS.
HIGH RISE BUILDING	2702.02.09	N/A	N/A	
MEANS OF EGRESS	2702.02.11	R	P	SEE LIGHTING PLANS FOR EXIT SIGNS.
SMOKE CONTROL SYSTEMS	2702.02.15	N/A	N/A	

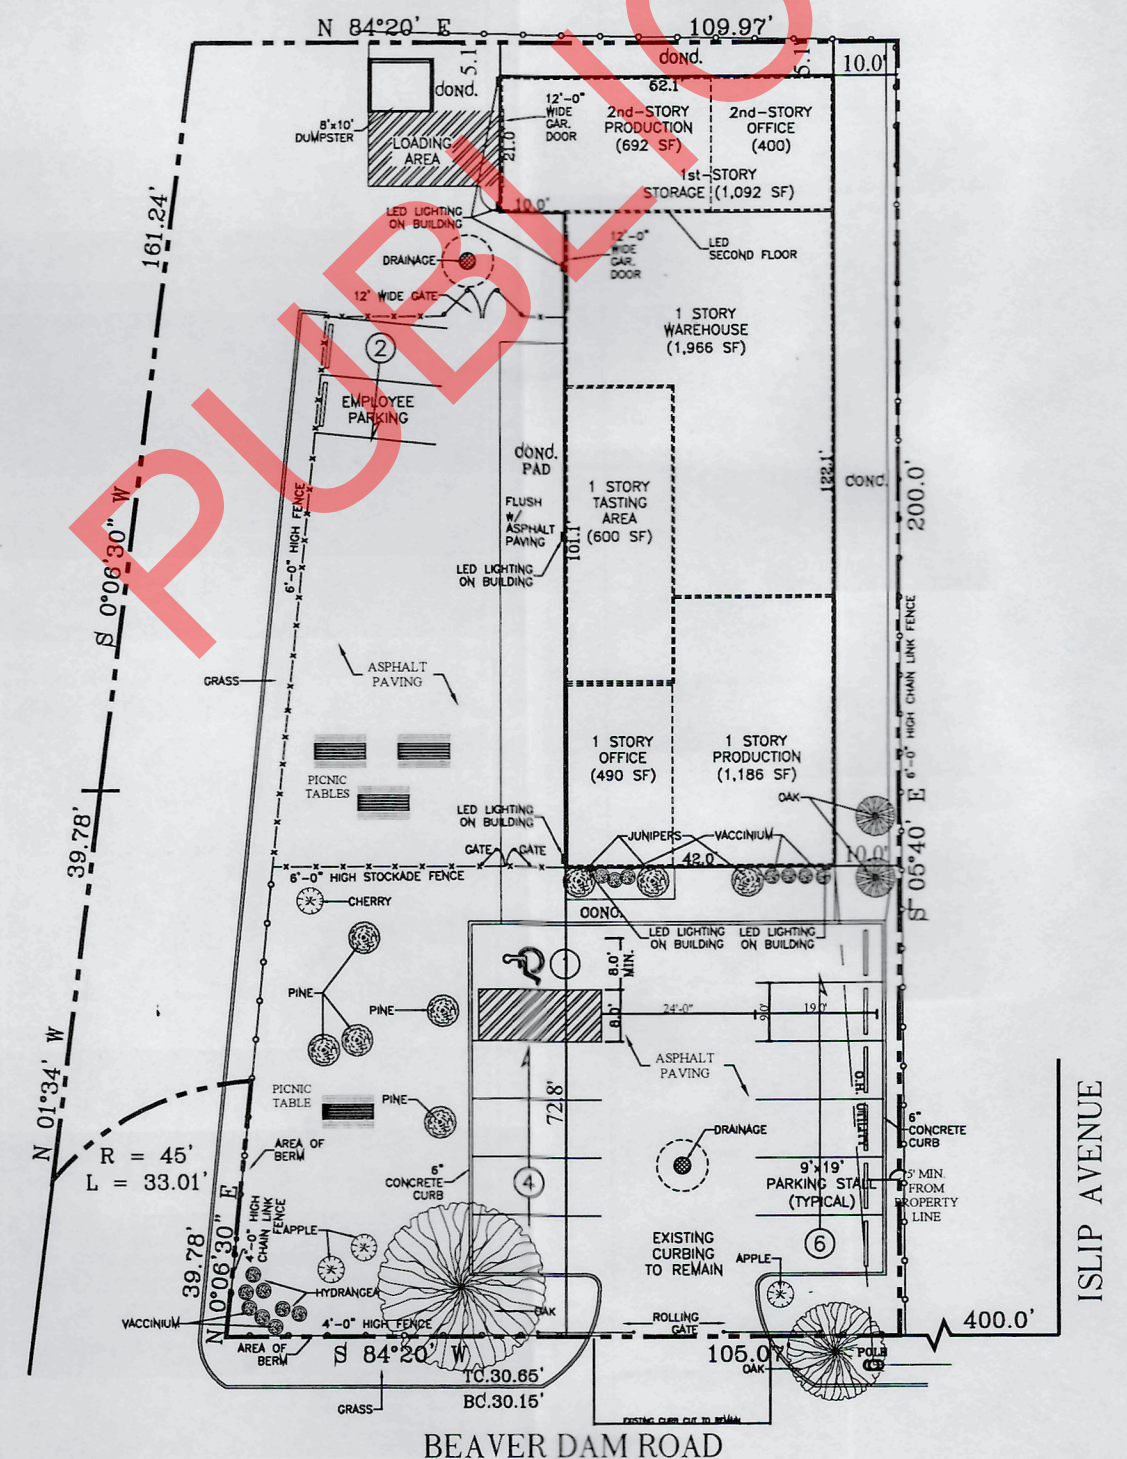

PLOT PLAN 1" = 30'-0"

INFORMATION ON PLOT PLAN TAKEN FROM SURVEY
PROVIDED BY: SCHNEPF & MURRELL - LAND SURVEYORS.

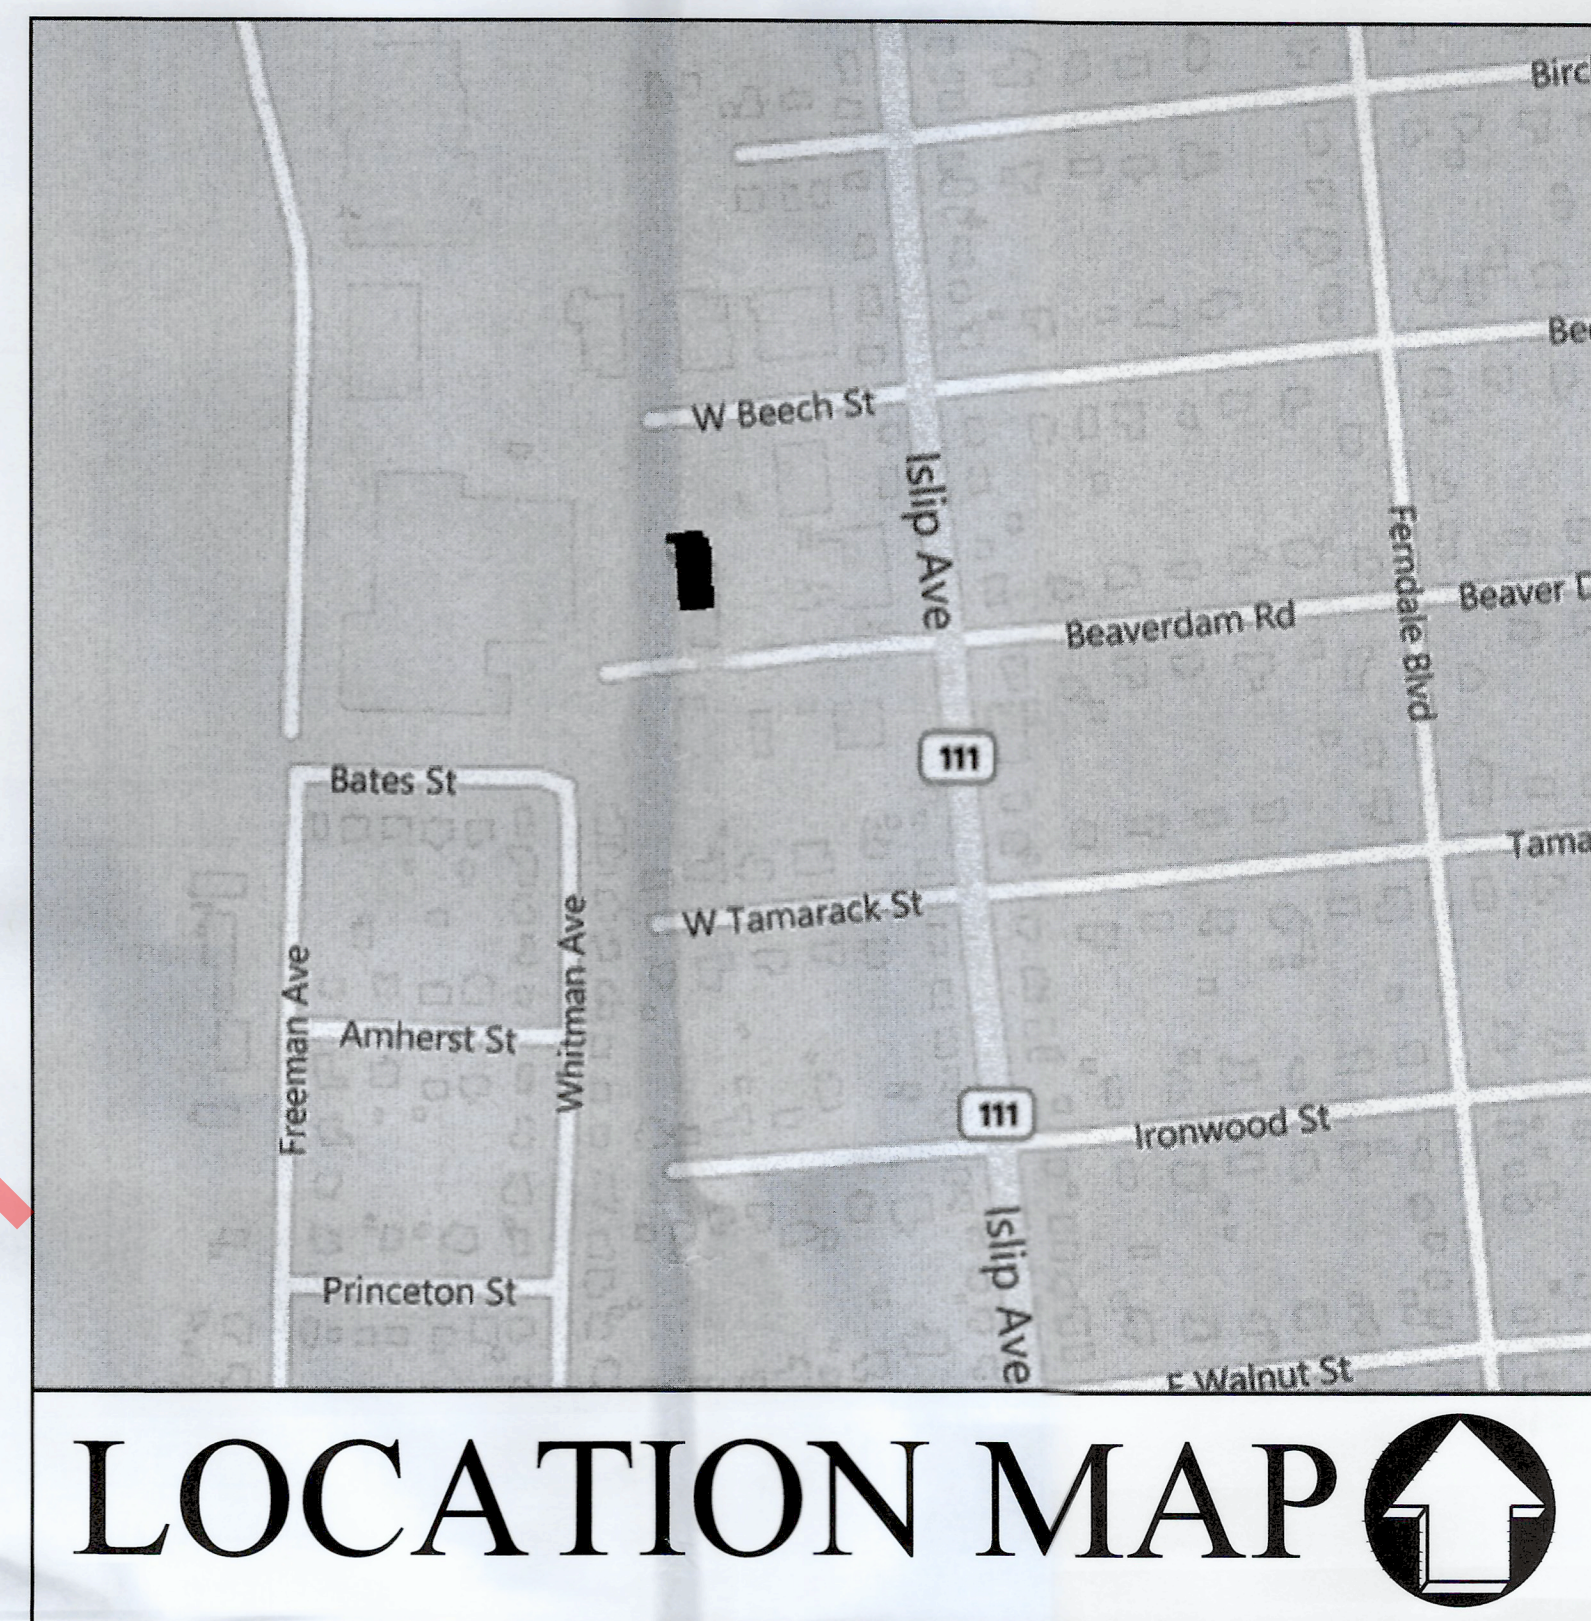

1 OF 7	COVER SHEET
2 OF 7	FLOOR PLAN: EXISTING/PROPOSED
3 OF 7	BUILDING CODE ANALYSIS
4 OF 7	EQUIPMENT SPECS
5 OF 7	HVAC PLAN
6 OF 7	LIGHTING PLAN
7 OF 7	TOILET DETAILS

SITE DATA - INDUSTRIAL 2 DISTRICT	
AREA OF SITE	23,496 S.F.
AREA OF EXISTING BUILDINGS	5,334 + 1,092 = 6,426 S.F.
EXISTING LOT COVERAGE	22.70%
PROPOSED F.A.R. CALCULATION	27.35%
AREA OF ASPHALT PAVING	7,4410 S.F.
AREA OF CONCRETE PAVING	1,318 S.F.
TOTAL PARKING REQUIRED: 16 SPACES	PROVIDED: 13 SPACES
TOTAL LOADING REQUIRED: 1 SPACE	PROVIDED: 1 SPACE
EXISTING ZONING	INDUSTRIAL 2 DISTRICT
INTENDED USE OF PROPERTY	INDUSTRIAL

PARKING CALCULATIONS			
AREA OF EXISTING BUILDING		6,426 SQ.FT.	
FIRST FLOOR = 5,334 SQ.FT.			
WAREHOUSE = 1 PER 1000		1,966 SQ.FT.	1.96
PRODUCTION = 1 PER 1000		1,186 SQ.FT.	1.19
STORAGE = 1 PER 1000		1,092 SQ.FT.	1.09
OFFICE = 1 PER 200		490 SQ.FT.	2.45
TASTING AREA = 1 PER 100		600 SQ.FT.	6
12.69 SPACES = 13 SPACES REQUIRED			
SECOND FLOOR = 1,092 SQ.FT.			
PRODUCTION = 1 PER 1000		692 SQ.FT.	.692
OFFICE = 1 PER 200		400 SQ.FT.	2
2.69 SPACES = 3 SPACES REQUIRED			
16 TOTAL SPACES REQUIRED		13 PROVIDED	

The posted plan is subject to change. Please note that this site plan may be modified during the Town Planning Board and/or Town Board review process. Please contact the assigned planning department staff member if you have questions regarding the date and status of any posted graphics.

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VL
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&
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TTRIFARO@DTTDESIGNS.COM
REVISION

[illegible]

DATE 3/5/202

SCALE AS NOTED

DRAWN BY T.G

CHECKED BY _____ V.L.

PROJECT NAME

BEAVER DAM BREWING CO.
1 BEAVER DAM ROAD
ISLIP,
N.Y. 11751

(INTERIOR ALTERATIONS)

SEA



SHEET TITLE

COVER
SHEET

JOB NUMBER

2019-84

SHEET NUMBER

1 OF 7